





KEY PLAN
(NOT TO SCALE)

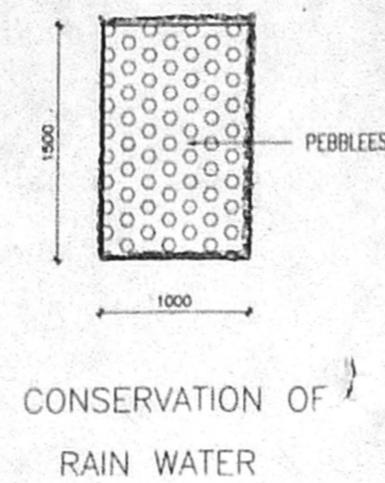


CONSERVATION OF
RAIN WATER

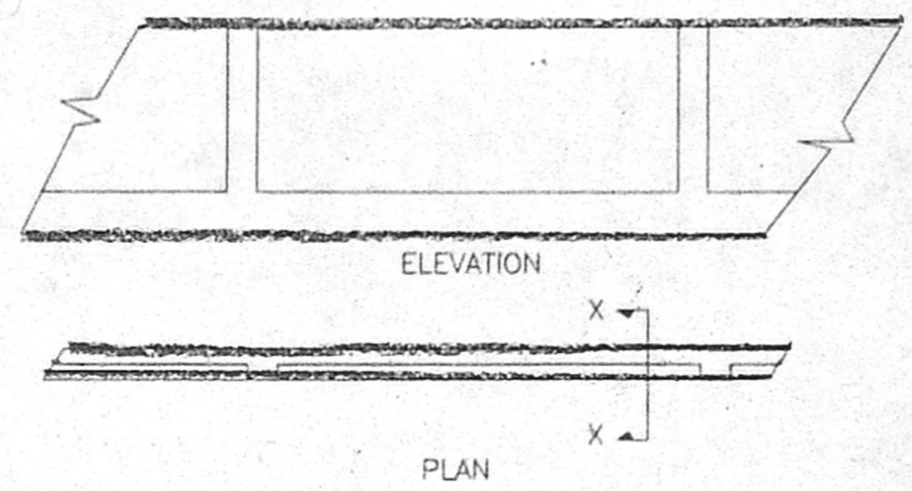


COMPOUND WALL DETAIL
(SCALE: 1:50)

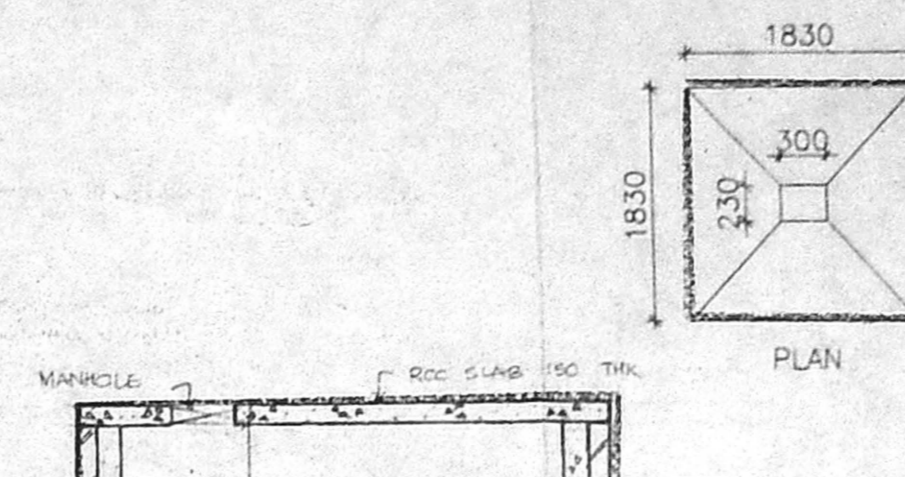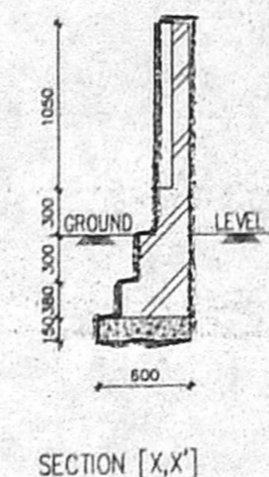


FOUNDATION DETAIL
(SCALE: 1:50)

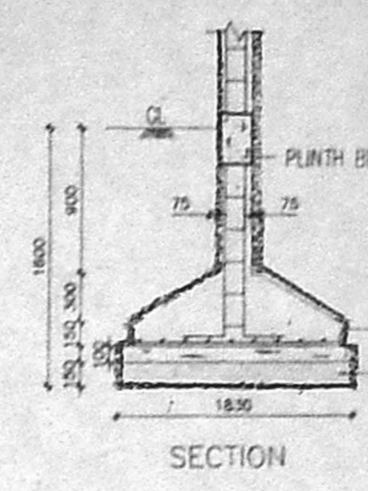


DETAIL OF SUMP (1:50)

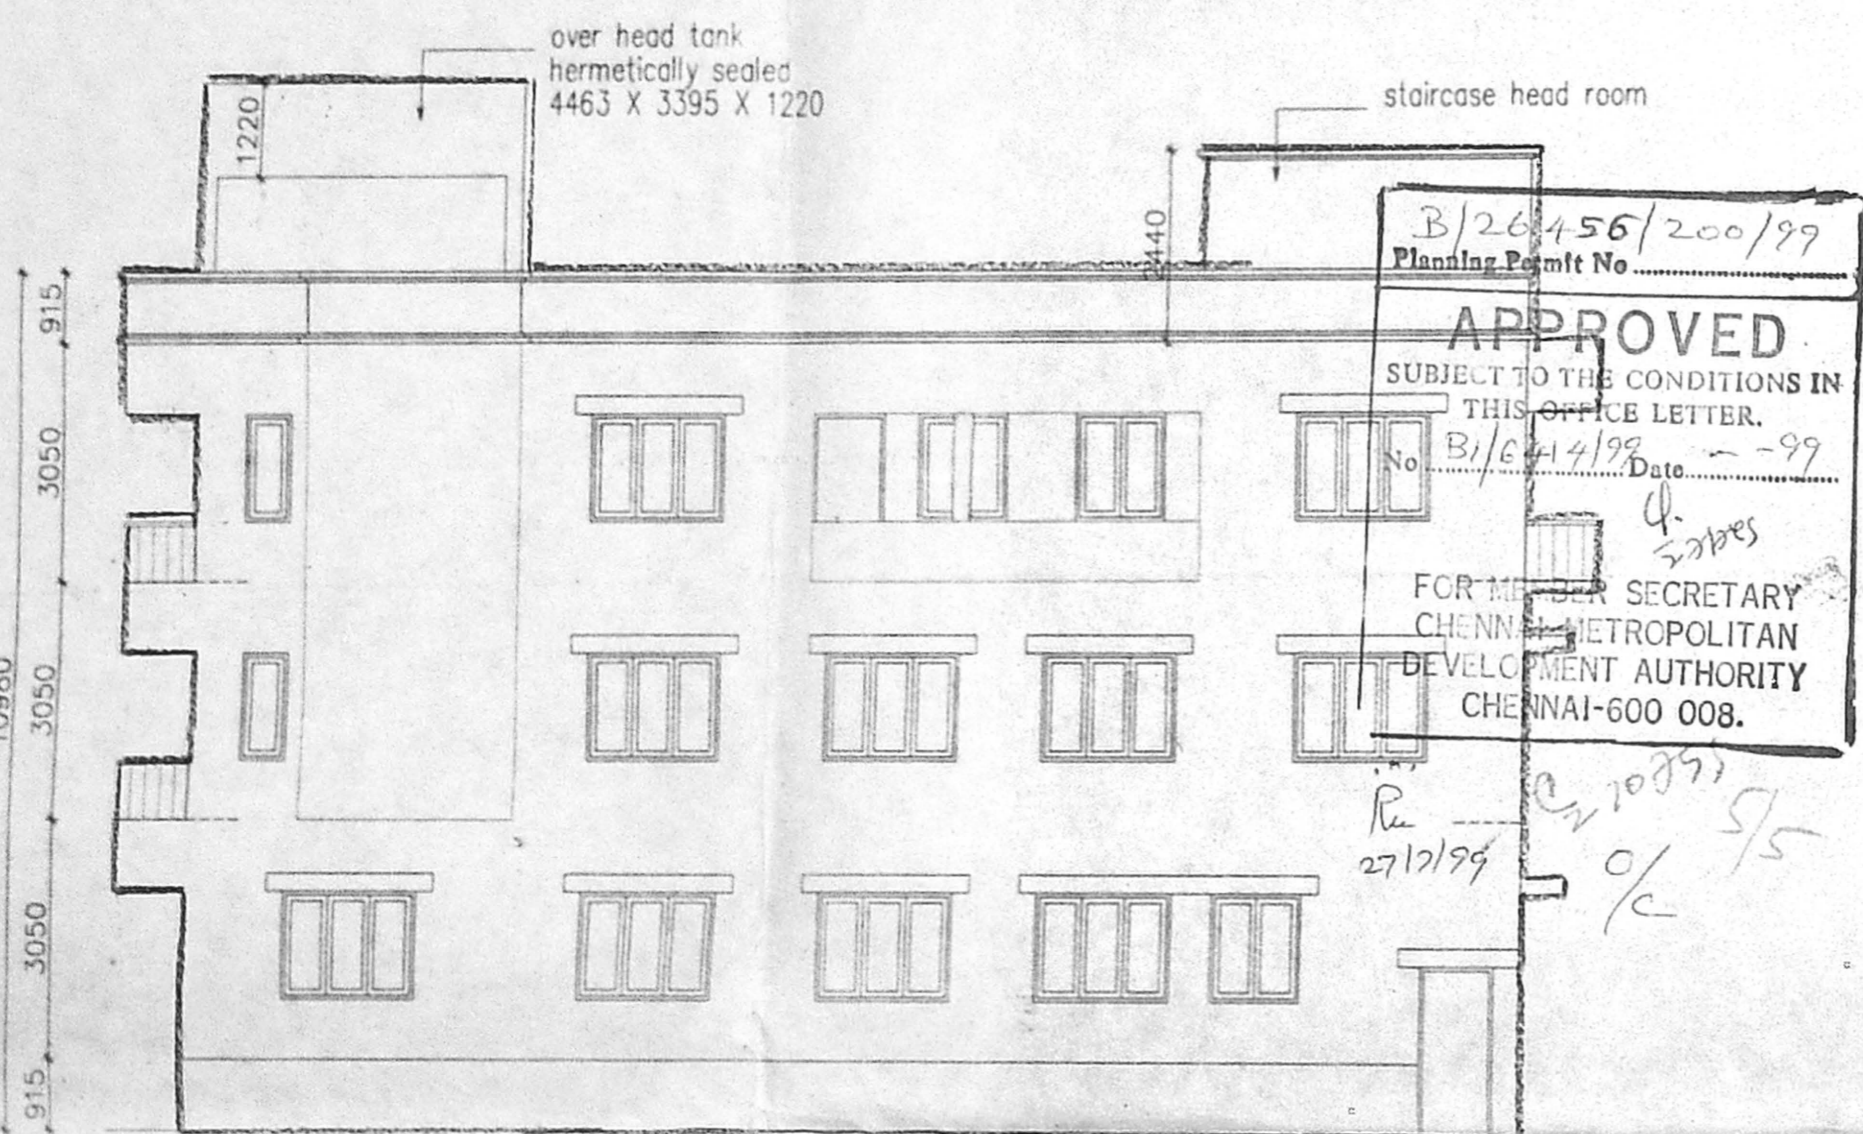

ELEVATION (1:100)

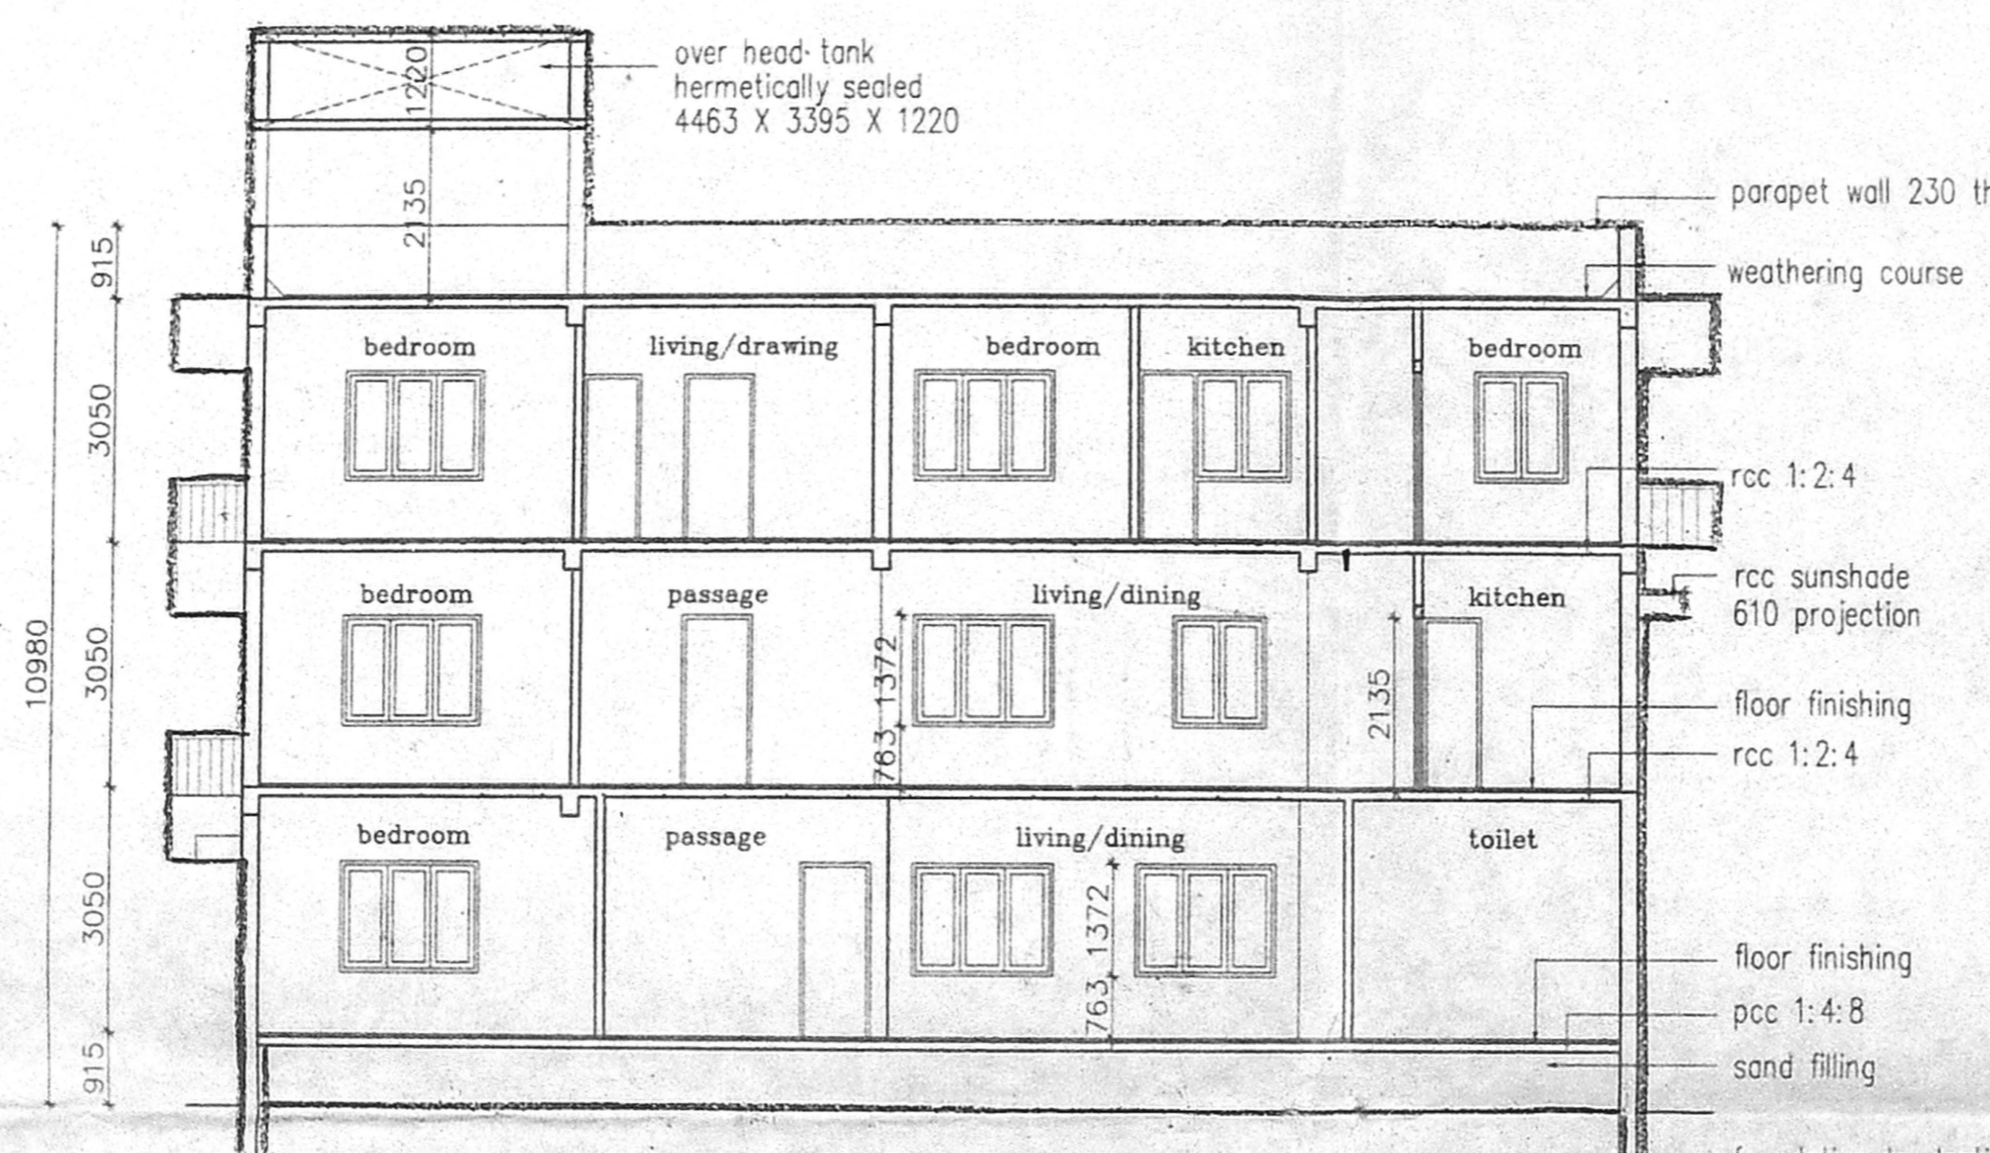

SECTION AA (1:100)

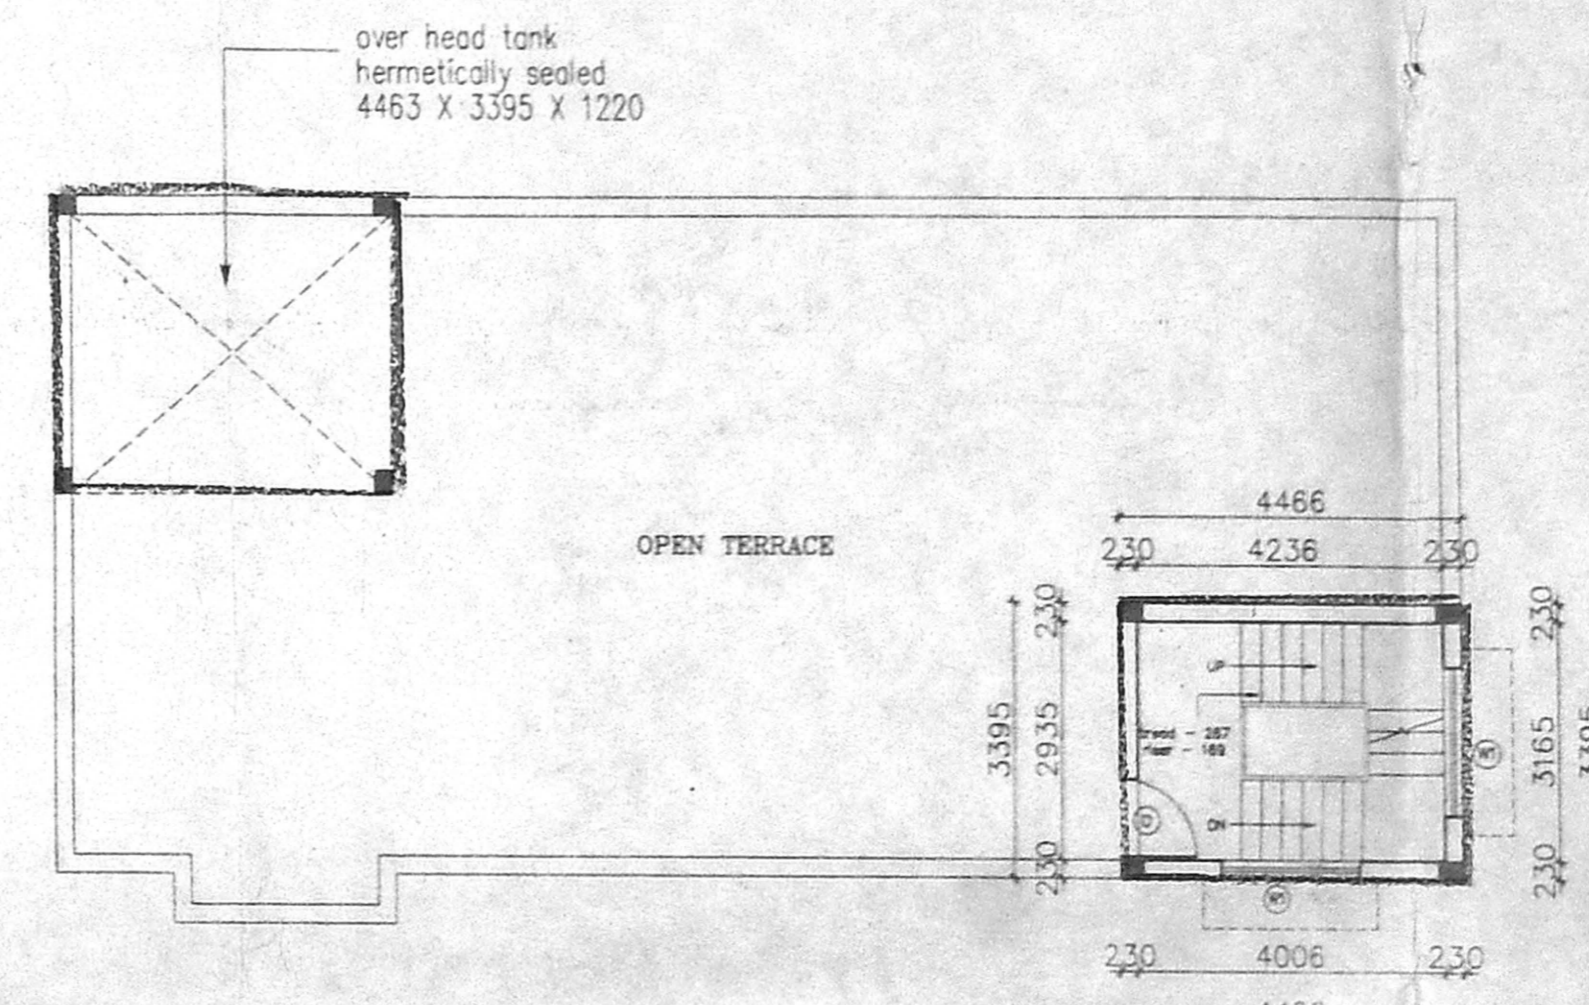

TERRACE FLOOR PLAN

SCHEDULE OF JOINERY:

TYPE	DETAIL	WIDTH	HEIGHT
MD	T.W. PANELLLED DOOR	1067	2100
D	T.W. FLUSH DOOR	1067	2100
D1	T.W. FLUSH DOOR	1067	2100
D2	T.W. FLUSH DOOR	1067	2100
PD	T.W. FLUSH DOOR	1067	2100
FW	T.W. FRENCH WINDOW	2592	2100
W1	T.W. GLAZED WINDOW	1830	1372
W2	T.W. GLAZED WINDOW	1830	1372
W3	T.W. GLAZED WINDOW	1200	1372
KW	T.W. GLAZED WINDOW	610	1067
V1	T.W. GLAZED VENTILATOR	610	610
V2	T.W. GLAZED VENTILATOR	610	610

SPECIFICATION

- FOUNDATION: RCC COLUMN FOOTINGS
- BRICK WORK: BRICKS FOR SUPER STRUCTURE
- PLASTERING: P.C.M 1:5 FOR WALLS & 1:3 FOR CEILING
- FLOORING: MOSAIC FLOORING
- CEMENT PAINT: A.P. PAINT FOR WALLS & D.P. PAINT FOR CEILING
- R.C.C: 1:2:4 FOR SLABS & LINTELS
- WOOD WORK: ALL WOOD WORKS IN BEST QUALITY TIMBER
- WEATHERING: B.JELLY LIME MORTAR OVER ROOF
- COURSE: SLAB ONE LAYER OF COUNTRY TILES

COLOUR INDEX:

- PROPOSED ROAD: [Color swatch]
- SITE BOUNDARY: [Color swatch]
- DEMOLITION: [Color swatch]
- SEWER LINE: [Color swatch]

AREA STATEMENT


	SQ. FT	SQ. M
SITE AREA	3744.00	347.95
GROUND FLOOR	1652.84	153.61
FIRST FLOOR	1716.22	163.37
SECOND FLOOR	1838.78	169.96
STAIRCASE HEADROOM	163.12	15.16
TOTAL BUILTUP AREA	5207.84	486.94
GROUND COVERAGE		44.14 %
F.S.I		1.4

PLAN SHOWING THE PROPOSED CONSTRUCTION OF RESIDENTIAL BUILDING AT OLD NO.4F, NEW NO.13, VEERABADRAN STREET R.S.NO.198/27, NUNGAMBAKKAM CHENNAI - 34 BLOCK NO. 24, DIVISION NO.108 ZONE VII.


SCALE : 1 : 100
DATE : 11TH MAR '99'
DRAWN : E. Vijayalakshmi

OWNERS SIGNATURE
C. S. Narayankan


ARCHITECT
Rohini Venkateswarar
Registered Architect
CA No: 15600
RA No: 332
20, Dr. Thiruvananthapuram
T. Nagar,
CHENNAI-600 016

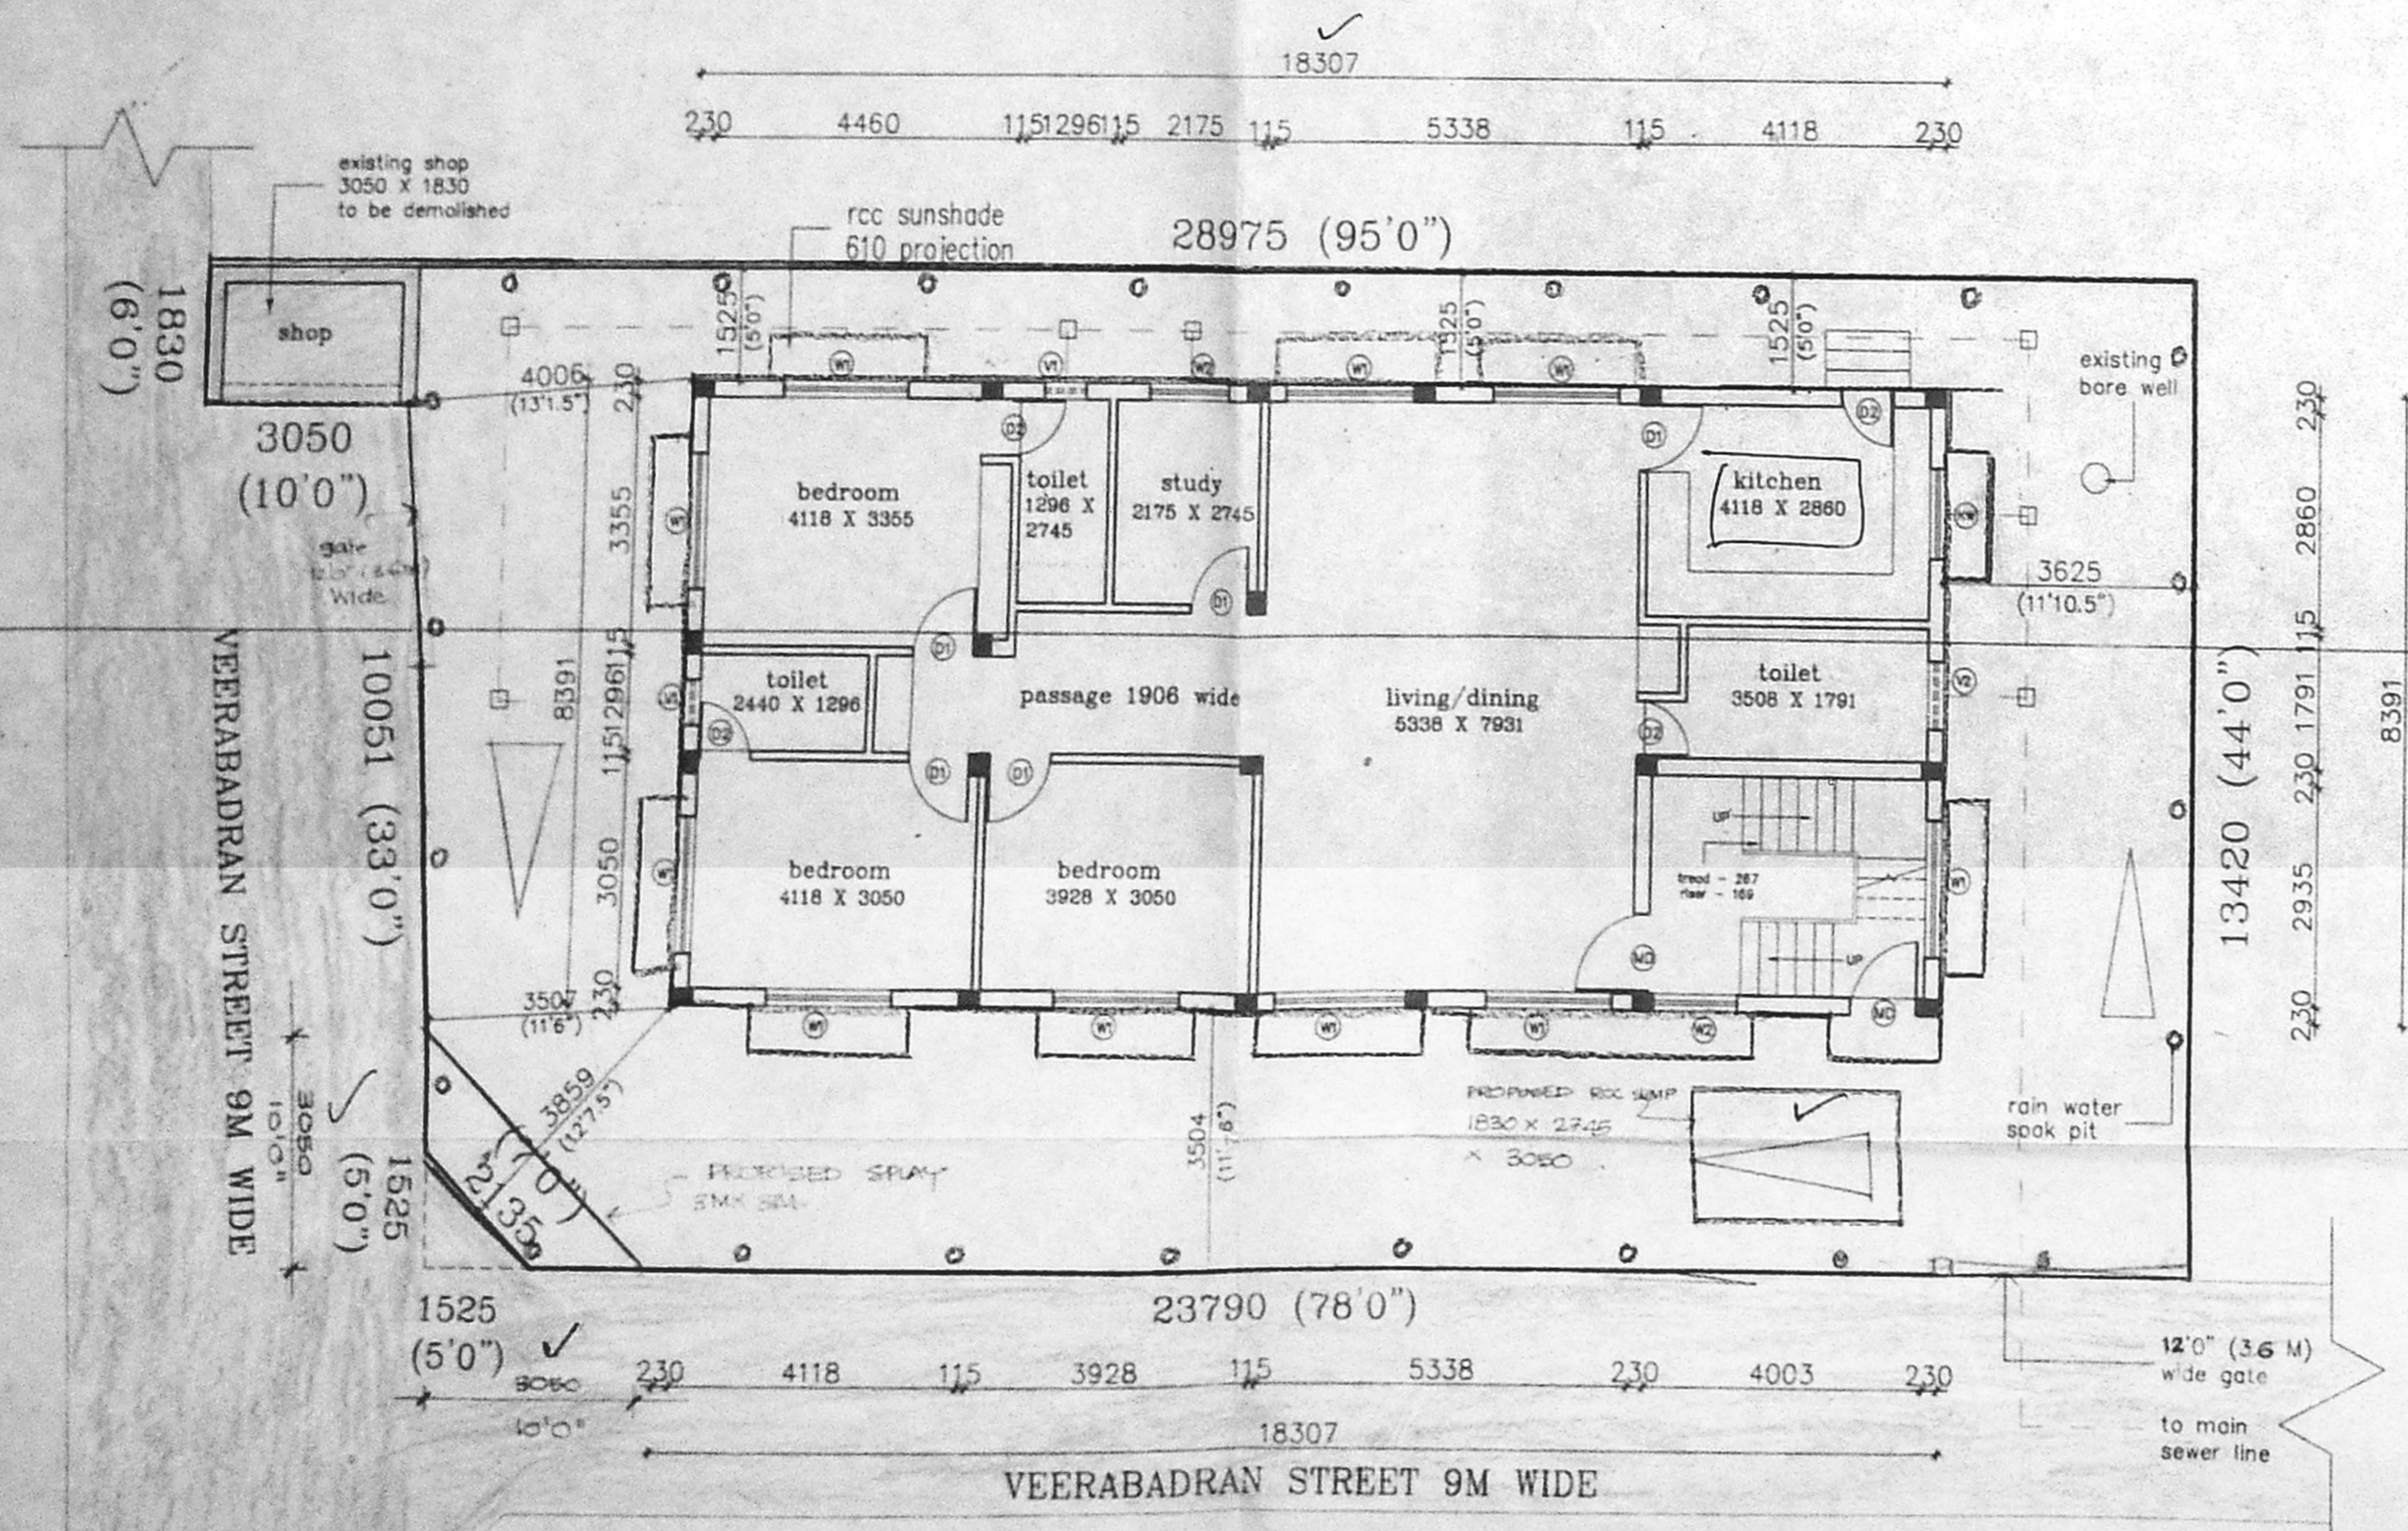

GROUND FLOOR PLAN IN SITE 1:100

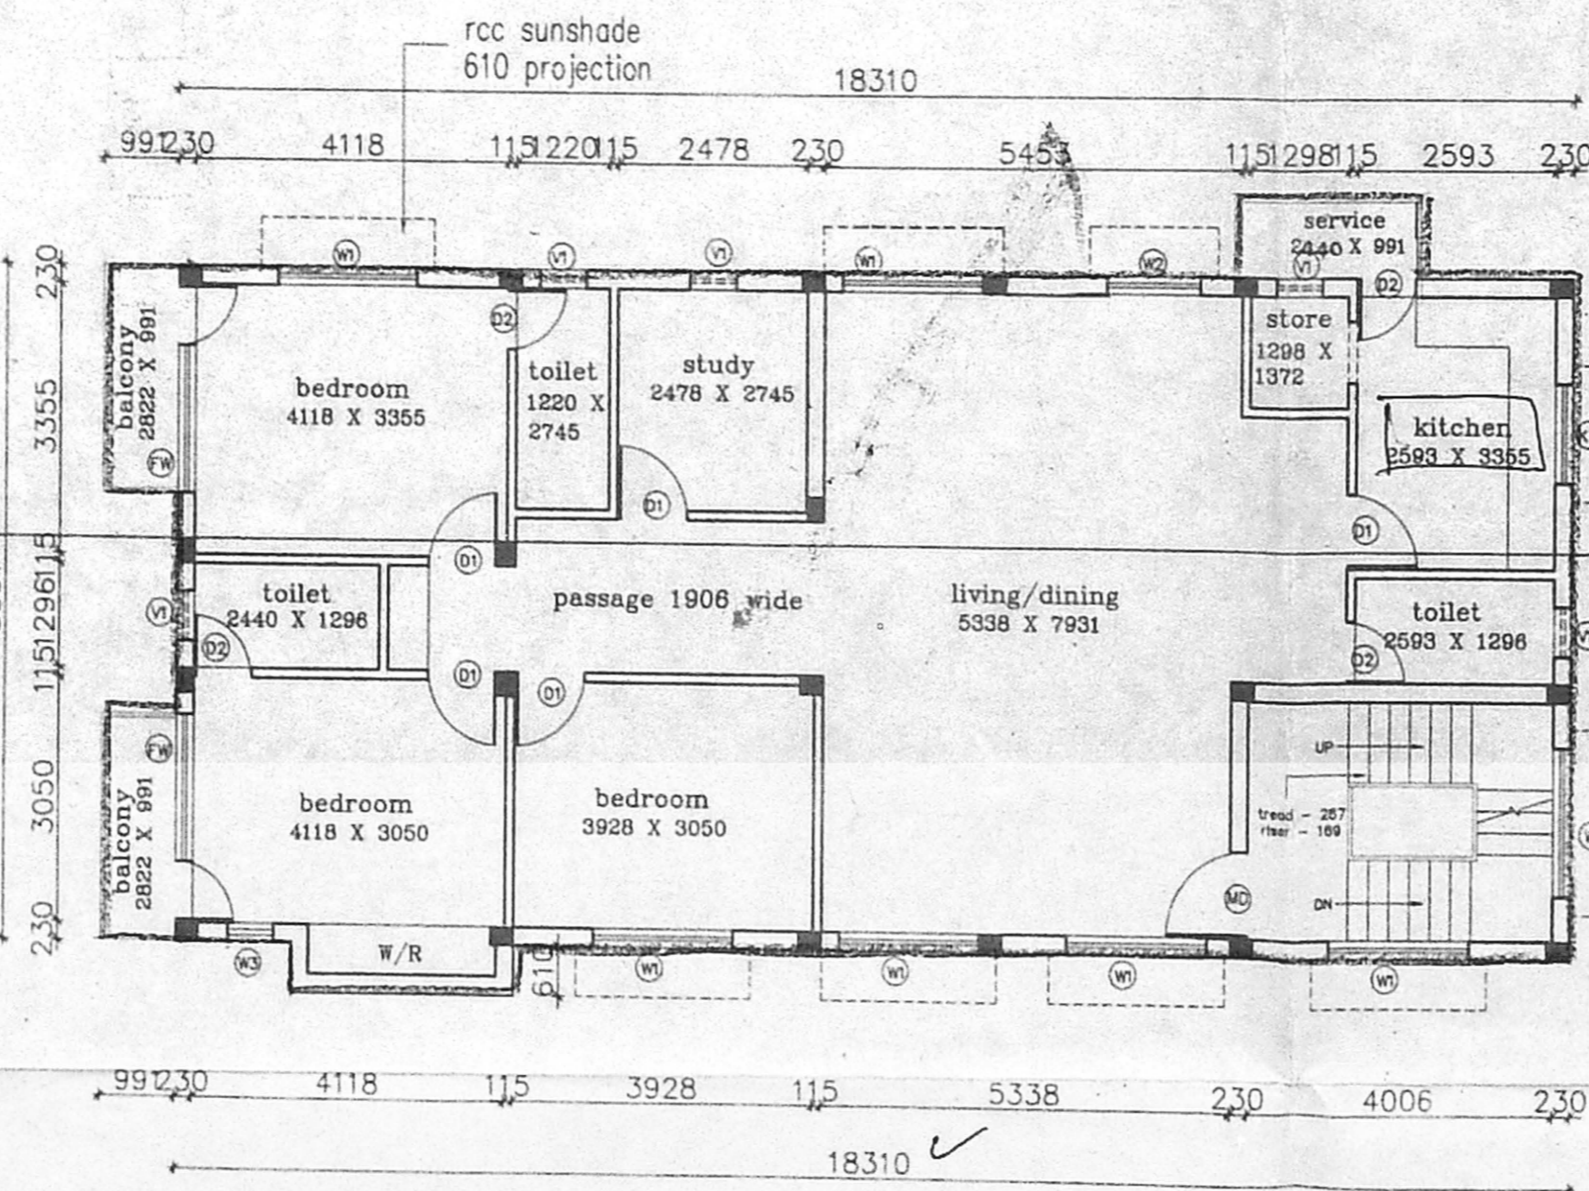

FIRST FLOOR PLAN 1:100

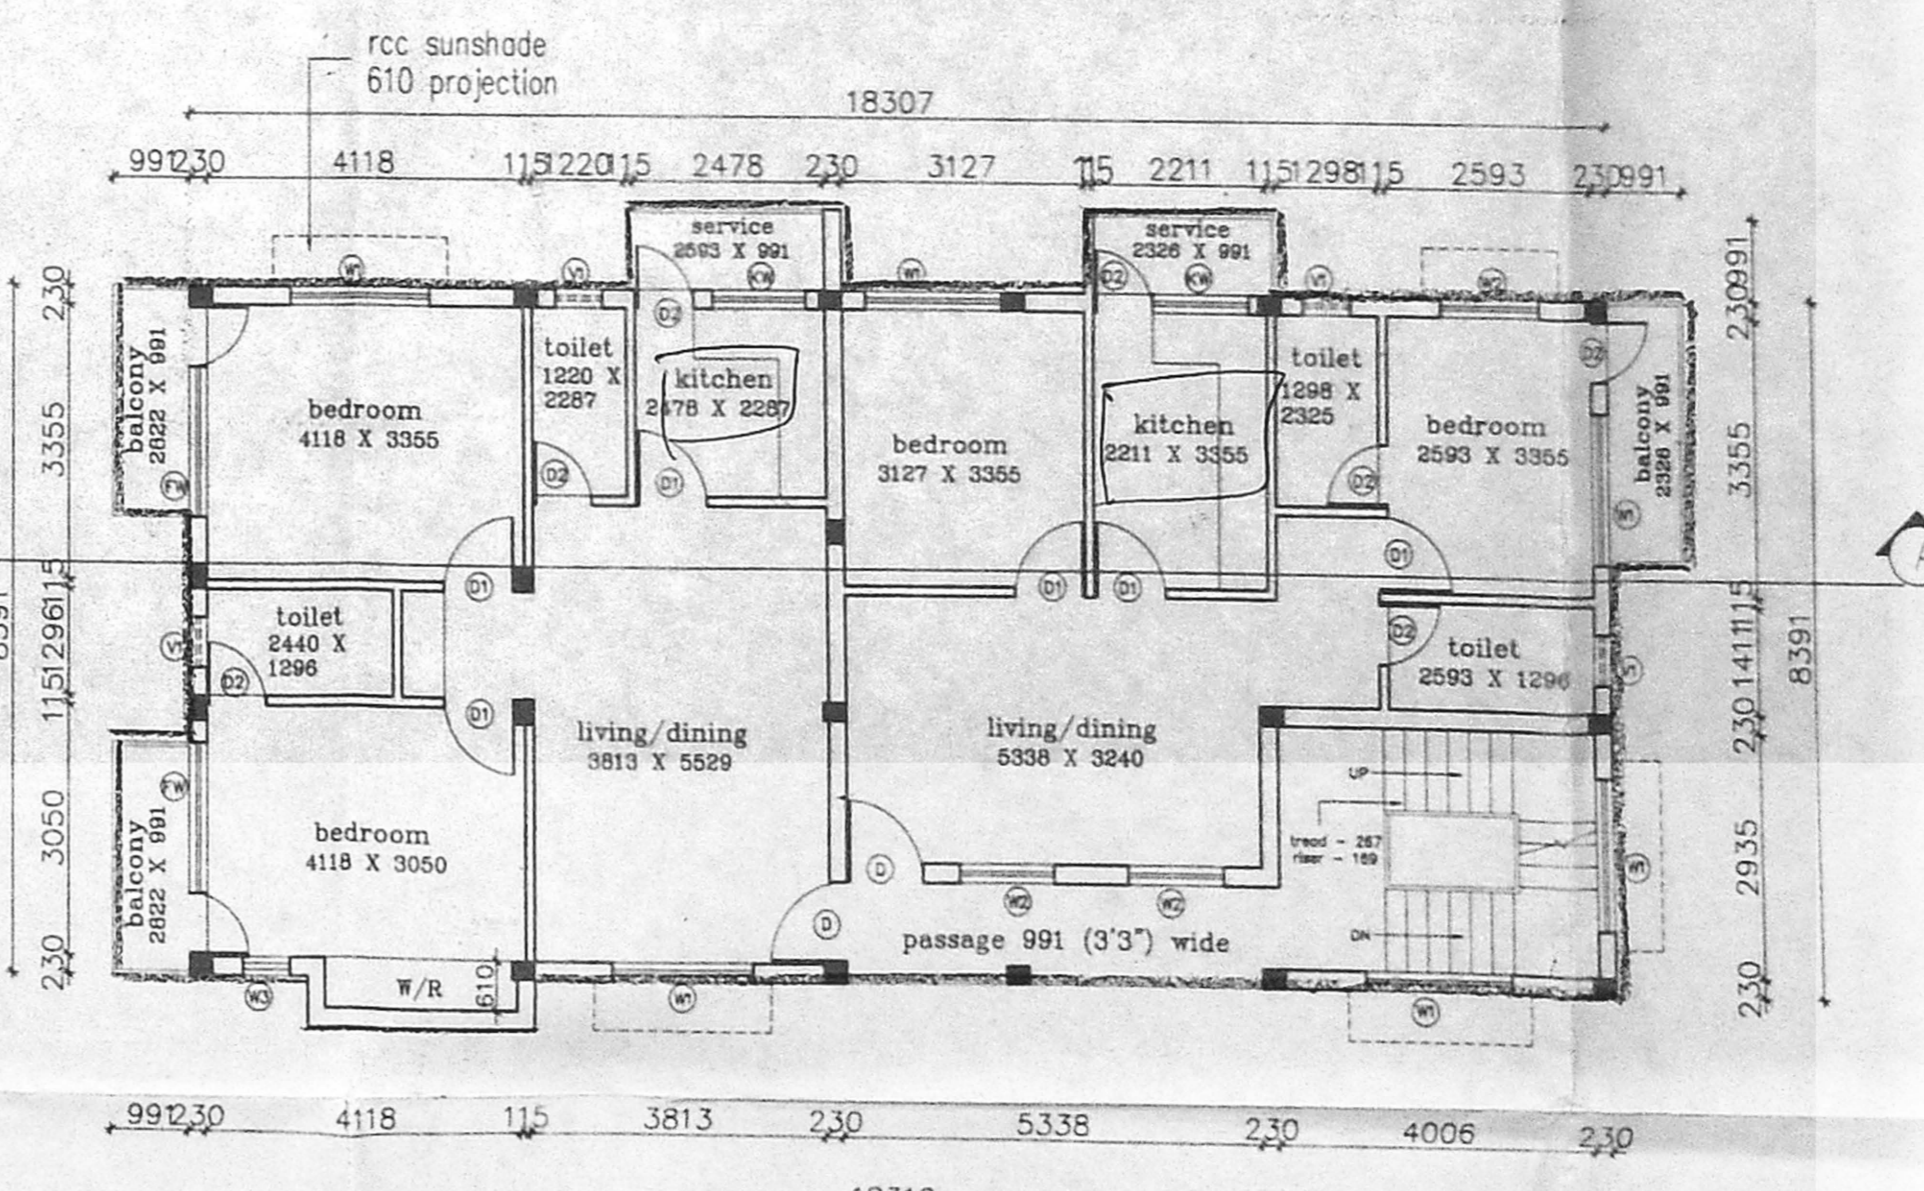

SECOND FLOOR PLAN 1:100

(all dimensions are in millimetres)